HIGH-LEVEL TACTILE **INSPECTIONS**

SAMPLING PHASE 1 REPORT Dryburgh Abbey PIC141



HISTORIC | ÀRAINNEACHD ENVIRONMENT | EACHDRAIDHEIL SCOTLAND | ALBA

Title:	High-Level Tactile Sample Inspection Project
Title.	Phase 1 Report PIC141 Dryburgh Abbey
Authors:	
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Version Control

Version	Date	Status	Prepared by	Amendments
V0001	02/08/2021	Draft		First draft
V0100	05/08/2021	Approved		Approved
V0200	27/08/2021	Approved		Identified Risk drawings revision A

HLTI Sampling: Report - Introduction



PIC ID # ↓	PIC141	Site n	name	Dryburgh Abbe	у		
Inspection start	26/07/2021	Inspec	ction end	29/07/2021		Submission	30/08/2021
Lead HBFA							
Sample Inspectors							

Introduction:

As a result of findings on the first four full site High-Level Tactile Inspections, SMT endorsed an accelerated programme that will see high-level tactile sample inspection carried out initial to 16 sites identified has high risk.

Sample inspection for Dryburgh Abbey was carried out in accordance with HES Management of Risk Presented by High-level Fabric Policy and High level Tactile Inspection Procedure.

Tactile inspections of three sample areas: West front door, South Range (West & South elevations) and Chapel Elevations (agreed in advance by the T1 team and the Region), were carried out and completed using a MEWP.

The Sample Inspection Report only reports on high level fabric risks within pre-determined areas and does not provide any assessment of risk in other areas on site.

HLF Inspection Risk Matrix:

HES-T1C-HLF-RAS-X-X-V0200-RiskMatrix

C	onsequence	1	2	3	4	5
Prob	ability	No injury	Minor injury	Moderate injury	Major injury	Fatal or life-altering injury
5	Fabric fall almost certain	5	10	15	20	25
4	Fabric fall highly likely	4	8	12	16	20
3	Fabric fall likely	3	6	9	12	15
2	Fabric fall unlikely	2	4	6	8	10
1	Fabric fall highly unlikely	1	2	3	4	5

RISK RATING	RISK SCORE RANGE
High	15-25
Medium	10- 14
Low	1-9

HLTI Sample Areas:

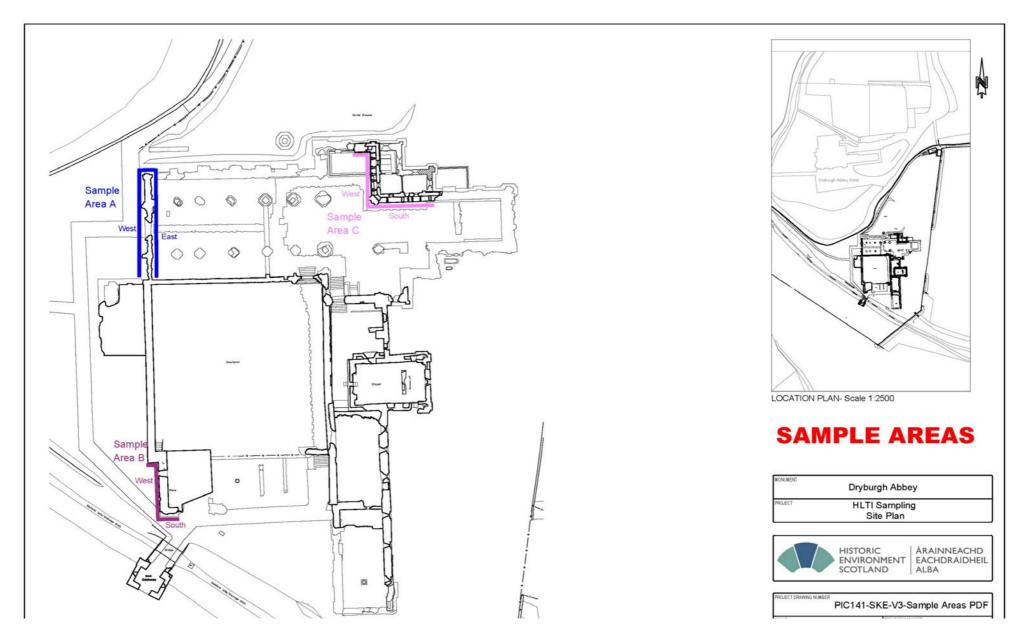
Area:	Colour:	Sample Area Name:
Α		West Front Door
В		South Range - West & South Elevations

HLTI Sampling: Report - Introduction

C Chapel Elevations



Click on link to open drawing in PDF viewer: PIC141-SKE-V3-SampleAreas.pdf



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HLTI Sampling: Report - High-Level Sample Areas Drawing



SITE DI ANI Scale 1:400		



UMIE	June 2021	DRAWN BY	
ARCHIVE N.M	E-COMP-DITION		

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HLTI Sampling: Report - Summary dashboard



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PIC ID# PIC141	Submission	30/08/2021			
Select Sample area of which da displayed ↓	ita should be	С		ber of rvations	25
Identified Risk	High 0		lium 0	Low 15	
Residual Risk	High		lium	Low	

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Ins	nec	tıor	nΔ	CTIC	۱n'
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Class V Report = Fabric		n = Risk of fabric falling	and causing harm	Monitor Observation /
detached during tactile inspection	High = Full site closure	Medium = Partial site closure	Low = Minor access restriction	Plan Repairs = No immediate action
0	0	0	7	22

Inspection types:	Tactile	25	Visual	0
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Key comments:

Three sample areas were inspected at Dryburgh Abbey. These included the West Front Door (remains of dressed stonework and exposed rubble wall core), West and South elevations of South Range (dressed ashlar and exposed rubble wall core) and the Chapel (dressed and carved stone).

High and medium risks were found on the West Front Door, resulting from detached and partially detached masonry at high-level.

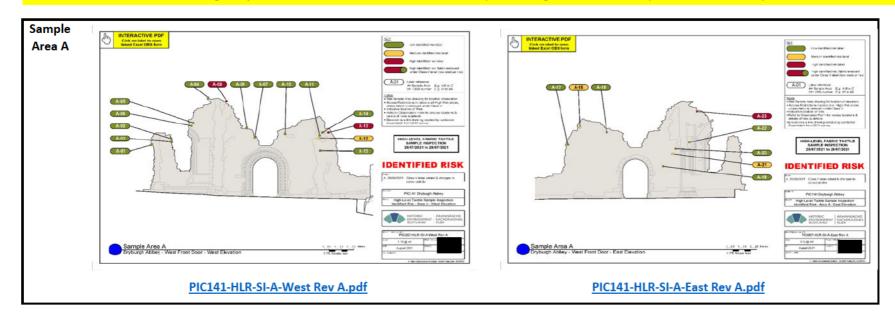
High risks were found on the West and South elevations of the South range, resulting from partially detached masonry and areas where there were multiple loose stones at risk of falling from height. Areas of high risk would result in barriers being put in place to protect life from the risk of falls, however, as the entire site is already barriered, no further barriers have been erected but site staff and the local MCU depot have been notified of the identified risks.

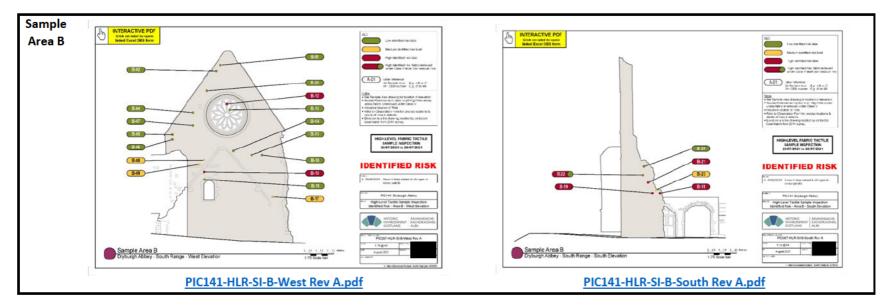
Low and Medium risks were found on the Chapel, which did not require any immediate action to maintain safety and risk

On the South elevation a fully detached stone was found, which was at immediate risk of falling and presented a hazard to life. This was removed in a controlled manner under Class V consent to maintain the safety of the site.



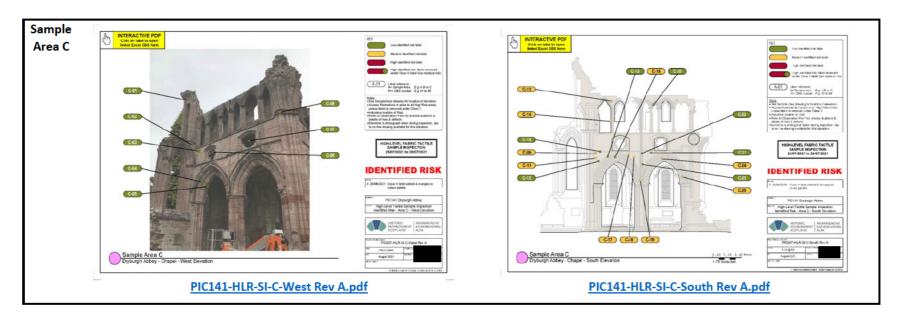
Click on link below image to open Interactive PDF in PDF viewer. In PDF viewer, the drawing is an interactive PDF, click on the labels to open the relevant OBS form for further information.





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